
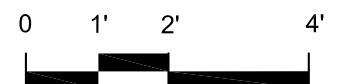


NOTES:

1. FOR TOP OF WALL (TW) & BOTTOM OF WALL (BW) ELEVATIONS, SEE GRADING PLAN.
2. END OF WALL- BEGIN CHAMFER & VERTICAL EXPANSION JOINT LAYOUT FROM EACH END CORNER. DO NOT INSTALL NOTCH WHERE WALLS INTERSECT (TYP.).
3. ALL CHAMFERED FACES SHALL BE GROUND SMOOTH BY GRINDING, SAND BLASTING OR OTHER METHOD TO REMOVE ALL IMPERFECTIONS, VOIDS, ROUGH EDGES OR OTHER UNDESIRABLE FINISHES.
4. ALL SURFACES THAT HAVE VOIDS AND HONEYCOMBING SHALL BE FILLED AND THE SURFACE SHALL BE REFINISHED BY SACKING, GRINDING, SAND BLASTING OR OTHER METHODS TO REMOVE ALL BURRS, IMPERFECTIONS AND OTHER UNDESIRABLE FINISHES FOR A UNIFORM FINISH.
5. ALL VERTICAL EXPANSION JOINTS SHALL BE SEALED WITH FLEXIBLE CONCRETE JOINT SEALANT CAPABLE OF ADHERING TO A VERTICAL SURFACE.
6. NOTCHES AND CHAMFERS SHALL TERMINATE AT THE INTERSECTION OF THE VERTICAL FACE AND PLAZA SURFACING.

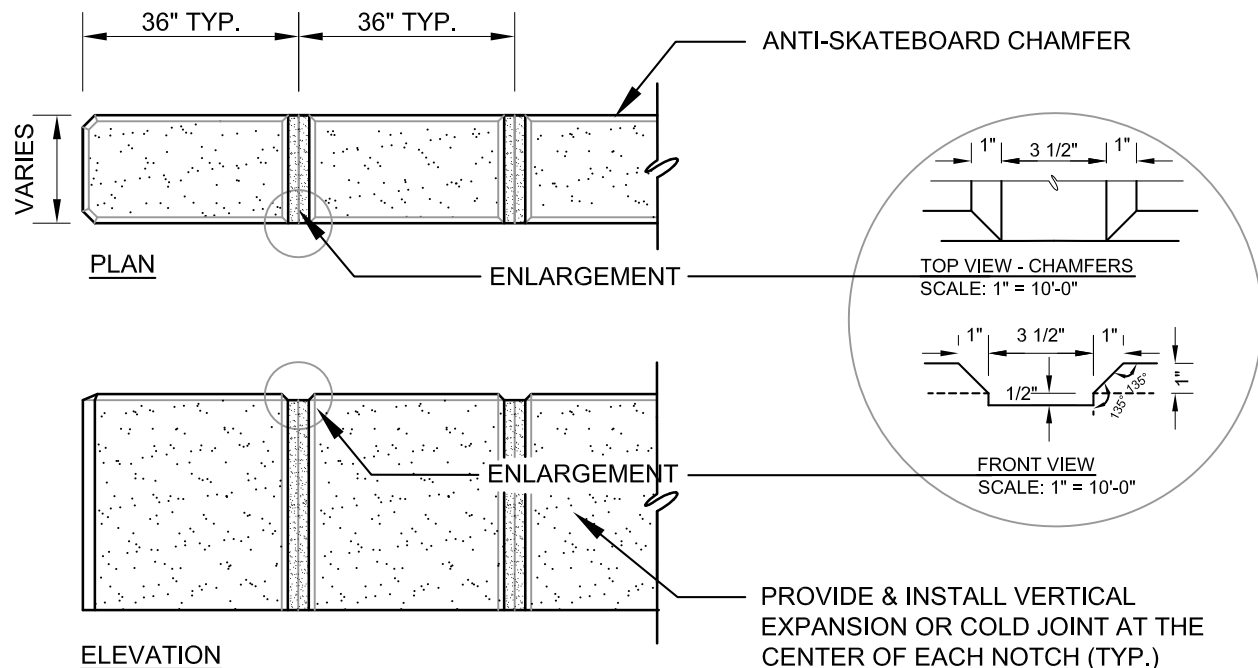

SCALE: 3/8" = 1'-0"

CITY OF FREMONT **PARK STANDARD DETAILS** **CHAMFERS IN SEATWALL**

DATE APPROVED BY CITY COUNCIL
December 13, 2011

RESOLUTION NO. 2011-65

SENIOR LANDSCAPE ARCHITECT

[Signature]

COMMUNITY SERVICES DIRECTOR

[Signature]

APR. REVISED DATE

REVISIONS

FILE NO. PSD CONC-10.DWG	SCALE 3/8" = 1'-0"	DRAWN TB	CHECKED MM	DATE 03/11/2011	DWG NO. PSD CONC-10	1 OF 1
-----------------------------	-----------------------	-------------	---------------	--------------------	------------------------	--------